

NORTH

Number Lumens Lamps Per Lamp 49 COOPER LIGHTING SOLUTIONS - LUMARK (FORMERLY EATON)

AXCS2A-W - MSP/DIM-L12 2A AXCENT SMALL LED WALLPACK WITH 3000K CCT AND 80 CRI LEDS 1 2164 20.7

GENERAL LIGHTING NOTES:

ALL BUILDING MOUNTED LIGHTS ARE TYPE SW1. LIGHTS WILL BE TURNED ON / OFF WITH A TIME CLOCK OR PHOTOCELL, AND WITH INTEGRATED MOTION SENSORS TO DIM THE LIGHTS TO WHEN NO MOTION IS DETECTED.

DO NOT REPRODUCE THESE DRAWINGS AND SPECIFICATIONS WITHOUT THE EXPRESSED WRITTEN PERMISSION OF THE DESIGNER. THE DRAWINGS AND SPECIFICATIONS ARE INSTRUMENTS OF THE SERVICE AND SHALL REMAIN THE PROPERTY OF THE DESIGNER WHETHER THE PROJECT FOR WHICH THEY ARE MADE IS EXECUTED OR NOT. THESE DRAWINGS AND SPECIFICATIONS SHALL NOT BE USED BY ANYONE ON ANY OTHER PROJECTS FOR ADDITIONS TO THIS PROJECT BY OTHERS EXCEPT BY THE EXPRESSED WRITTEN PERMISSION OF THE DESIGNER.

386 Indian Roau
Grand Junction, CO 81501
Phone: (970) 241-8709
Bighorn Consulting Engineers, Ir

A STORAGE PLAC LIGHTING SITE PL 1960 HIGHWAY 6 & 50 FRUITA, COLORADO PLA

DATE: ISSUED FOR: 12/09/2022 PERMIT

12/09/2022 22-355

BCE BCE DRAWN BY: CHECKED BY: SCALE: AS SHOWN SHEET NUMBER: ES1-1





Lumark

Axcent

Wall Mount Luminaire

Product Features













Connected Systems

 WaveLinx Lite Enlighted

Quick Facts


- Available in 14W 123W (1,800 17,000 lumens)
- Full cutoff and refractive lens models available
- Energy and maintenance savings up to 95% compared to HID
- Energy efficient illumination results in up to 144 LPW
- Replaces 70W up to 450W HID equivalents

Interactive Menu

 Ordering Information page 2 Mounting Details page 3 Product Specifications page 4

• Control Options page 6

• Energy and Performance Data page 4

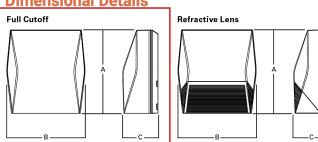

3-5/8" [94mm]


6-1/8" [155mm]

		V		_
:a			в	
	AXCS Small		AXCL Large	
	8" [202mm]		11-1/2" [292mm]	7
	7-1/2" [190mm	1]	10-3/4" [273mm]	7

4-7/8" [124mm]

7-1/8" [181mm]

A 1 1 1 1	
Ordering Inforn	nation
Oracining innorm	lation
OALABI E AULABED AN	2014 AD 0471/
SAMPLE NUMBER: AXO	JS1A-AP-34/V

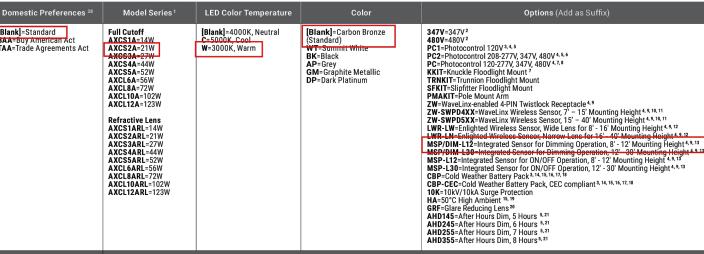

VS/AXCS-XX=Vandal Shield Axcent Small ^{7, 23}
VS/AXCS-MS=Vandal Shield Axcent Small (With Motion Sensor) ^{7, 23}
WG/AXCS-Wire Guard Axcent Small (With Motion Sensor) ⁷
VS/AXCL-XX=Vandal Shield Axcent Large ^{5, 23}
VS/AXCL-XX=Vandal Shield Axcent (With Motion Sensor) ^{8, 23}
VS/AXCL-MS=Vandal Shield Axcent (With Motion Sensor) ^{8, 23}
WG/AXCL-Wire Guard Axcent arge ⁵
WG/AXCL-Wire Guard Axcent (With Motion Sensor) ⁵
BB/AXC-Axcent Lumen Select Back Box, Carbon Bronze ^{24, 25}
BB/AXC-WT-Axcent Lumen Select Back Box, Summit White ²⁴
BB/AXC-WT-PC=Axcent Lumen Select Back Box, Summit White ²⁴
BB/AXC-WT-PC=Axcent Lumen Select Back Box with PC, Summit White ^{24, 25}

 DesignLights Consortium® Qualified. Refer to www.designlights.org Qualified Products List under Family Models for details.

2. Transformer used only when ordered with motion sensor or AXCS1 through AXCS5 or AXCL6 fixture

3. Not available in 347 or 480 VAC. Not available in 347 of 450 VAC.
 Button photocontrol and any motion sensor (MSP, ZW, or LWR) not offered together.
 Only available on AXCL6-AXCL12 models.

6. Used with 277, 347, and 480 VAC options.
7. Only available on AXCS1-AXCS5 models. 8. This configuration may contain materials that are not RoHS compliant. Contact your lighting 9. Uses deep back housing.

10. Sensor passive infrared (PIR) may be overly sensitive when operating below -20°C (-4°F). For the device to be field-configurable, requires WAC Gateway components WAC-PoE and WPOE-120 in appropriate quantities. Only compatible with WaveLinx system and software and requires system mponents to be installed for operation. See website for more Wavelinx application information. 11. Replace XX with sensor color (WH, BZ, or BK).

LWP-GW-1, and LWP-PoE8 in appropriate quantities. See website for application information. 13. The ISHH-01 accessory is required to adjust parameters.

14. Ambient operating temperature -20°C to 25°C for AXCL6 through AXCL10. Ambient operating temperature -20°C to 30°C on AXCS4 models. Ambient operating temperature -20°C to 40°C on AXCS1

PMAKIT-XX-Pole Mount Kit
ISHH-01-Integrated Sensor Programming Remote ²⁶
MAIUTU-XX-Single Tenon Adapter for 3-1/2 U.D. Tenon
MA1011-XX=2@180° Tenon Adapter for 3-1/2° U.D. Tenon
MA1017-XX=Single Tenon Adapter for 2-3/8° U.D. Tenon
MA1018-XX=2@180° Tenon Adapter for 2-3/8° U.D. Tenon
SWP04-XX=WaveLinx Wireless Sensor, 7' - 15' Mounting Height ^{10, 11, 27}
SWPD5-XX=WaveLinx Wireless Sensor, 15' - 40' Mounting Height ^{10, 11, 27} 16. Uses deep back housing for AXCS1, AXCLS2, AXCS3, and AXCS4 models.

17. Not to be mounted in upwards / inverted orientation. Downlight wall mount only for AXCS1 through 18. CBP cannot be used with PC and motion sensor (MSP, ZW, or LWR). CBP can be used with PC or

KKIT/AXCS-XX=Knuckle and Visor Floodlight Kit (For Axcent Small) 7
SFKIT/AXCS-XX=Slipfitter Floodlight Kit (For Axcent Small) 7
TRNKIT/AXCS-XX=Trunnion and Visor Floodlight Kit (For Axcent Small) 7
TRNKIT-XX=Trunnion Floodlight Kit (For Axcent Large) 8
STRINKIT-XX=Sitriter Floodlight Kit (For Axcent Large) 9
PMAKIT-XX=Pole Mount Kit

PMAKIT-XX=Pole Mount Kit

motion sensor (MSP, ZW, or LWR).

19. Can not be ordered with CBP or PC options. 20. Use dedicated IES files on product website for lumen values and distributions. 21. Requires the use of PC1 or PC2 button photocontrol. See After Hours Dim supplemental guide for

22. Replace XX with color designation. 23. For use with full cutoff lens configurations only. LWR). Photocontrol back box not available with any photocontrol or motion sensor options (PC, MSP, ZW,

25. Photocell only operates at 120-277V input voltages. Not for use with 347 or 480V systems. 26. This tool enables adjustment to parameters including high and low modes, sensitivity, time delay, cutoff and more. Consult you lighting representative for more information.

27. Requires 4-PIN twistlock receptacle (ZW) option. 28. Only product configurations with these designated prefixes are built to be compliant with the Buy

American Act of 1933 (BAA) or Trade Agreements Act of 1979 (TAA), respectively. Please refer to
DOMESTIC PREFERENCES website for more information. Components shipped separately may be seperately analyzed under domestic preference requirements. Consult factory for further information.

Stock Ordering Information


15. Not available with AXCS5 or AXCL12 models.

			Model	Series ¹	
		Full (Cutoff	Refra	ctive Lens
	AXCS1A=14W		AXCL10A=102W	AXCS1ARL=14W	AXCL10ARL=102W
	AXCS2A=21W		AXCL12A =123W	AXCS2ARL=21W	AXCL12ARL=123W
_	AXCS3A=27W		AXCL6A-347V=56W	AXCS3ARL=27W	AXCL6ARL-347V=56W
	AXCS4A=44W		AXCL8A-347V=72W	AXCS4ARL=44W	AXCL8ARL-347V=72W
	AXCS5A=52W		AXCL10A-347V=102W	AXCS5ARL=52W	AXCL10ARL-347V=102W
	AXCL6A=56W		AXCL12A-347V=123W	AXCL6ARL=56W	AXCL12ARL-347V=123W
	AXCL8A=72W			AXCL8ARL=72W	


Note: All stock configurations are 4000K color temperatures, standard Carbon Bronze finish, and wall mount configuration


AXCS / AXCL Axcent Lumark


Mounting Details

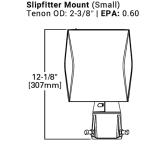


Trunnion Mount (Small)

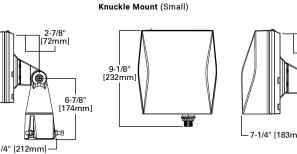


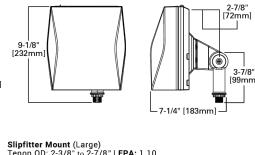

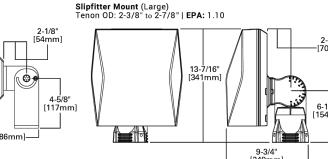

Pole Mount Arm (Large) EPA: 1.10

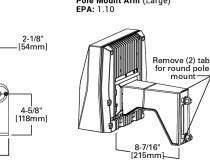

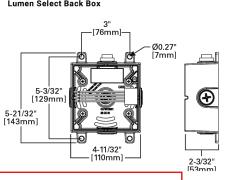

The separate emergency lighting LEDs are wired

to provide redundant emergency lighting. Listed to UL Standard 924, Emergency Lighting

Five-stage super TGIC polyester powder coat paint,

Shipping Data

Small fixture=5 lbs. [2.36 kgs.]

Large fixture=12 lbs. [5.45 kgs.]


Small with sensor or CBP=10 lbs. [4.40 kgs.]


Large with sensor or CBP=17 lbs. [7.73 kgs.]


Large with sensor & CBP=21 lbs. [9.54 kgs.]


Trunnion Mount Detail


Pole Mount Arm Drill Pattern

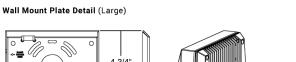


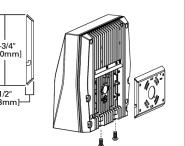

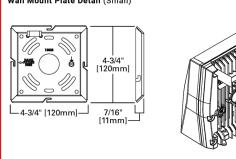


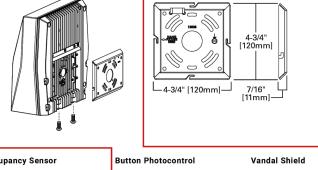

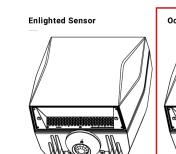

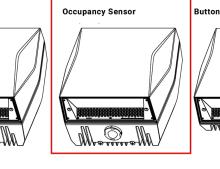



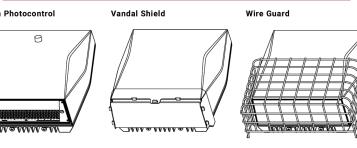

Product Specifications

Construction Die-cast aluminum housing

· External back fin design extracts heat from the surface to thermally optimize design for longer

Dark Sky Approved (Fixed mount, Full cutoff, and 3000K CCT only) Silicone-sealed optical LED chamber

 Acrylic refractive or full cutoff lens options for Type IV distributions

Electrical Standard universal voltage (120-277V, 50/60Hz)

 Driver incorporates 6kV surge protection -40°C minimum operating temperature 40°C maximum operating temperature <20% total harmonic distortion

Steel wedge mounting plate fits directly to 4" standard j-box or directly to wall with the "Hook-N-Lock" mechanism

 Stainless steel set screws • Lumen Select Back Box accessory offers four 1/2" NPT conduit entry wire ways. Resistor Pack combinations allow field-dimming of 75% or 50%

0-10V dimming driver is standard with leads external to the fixture

when connected to luminaire dimming leads Not suitable for indoor use when installed in

Emergency Egress

Optional integral cold weather battery emergency egress includes emergency operation test switch, an AC-ON indicator light and a premium, maintenance-free battery pack

Energy and Performance Data Power and Lumens (Avcent Small)

Power and L	umens (Axcent Sma	II)		ı			
Light Engine		AXCS1A	AXCS2A		AXCS3A	AXCS4A	AXCS5A
Power (Watts)		14	21		27	44	52
Input Current (@ 120V (A)	0.12	0.18		0.23	0.37	0.43
Input Current (@ 240V (A)	0.06	0.09		0.11	0.18	0.22
Input Current (@ 277V (A)	0.05	0.08		0.10	0.16	0.19
Input Current (@ 347V (A)	0.04	0.06		0.08	0.13	0.15
Input Current (@ 480V (A)	0.03	0.04		0.06	0.09	0.11
Configuration	1						
Full	4000K/5000K Lumens	1,806	2,561		3,537	5,520	6,300
Cutoff	3000K Lumens	1,526	2,164		2,989	4,665	5,324
	BUG Rating	B1-U0-G0	B1-U0-G0		B1-U0-G0	B2-U0-G1	B2-U0-G1
Refractive	4000K/5000K Lumens	1,915	2,716		3,704	5,858	6,699
Retractive Lens	3000K Lumens	1,618	2,295		3,130	4,950	5,661
	BUG Rating	B1-U3-G2	B1-U3-G2		B1-U3-G2	B1-U4-G3	B1-U4-G3

Power and Lumens (Axcent Large)

Light Engine		AXCL6A	AXCL8A	AXCL10A	AXCL12A
Power (Watts)		56	72	102	123
Input Current	@ 120V (A)	0.44	0.60	0.83	1.01
Input Current	@ 240V (A)	0.22	0.31	0.41	0.51
Input Current	@ 277V (A)	0.20	0.27	0.36	0.45
Input Current	@ 347V (A)	0.17	0.22	0.30	0.37
Input Current	@ 480V (A)	0.13	0.16	0.22	0.27
Configuration	n				
	4000K Lumens	7,594	9,696	13,283	16,823
Full	5000K Rating	7,465	9,531	13,058	16,538
Cutoff	3000K Lumens	6,619	8,450	11,577	14,662
	BUG Rating	B1-U0-G1	B1-U0-G1	B3-U0-G2	B3-U0-G2
	4000K Lumens	7,809	9,970	13,641	17,346
Refractive	5000K Rating	7,689	9,817	13,450	17,034
Lens	3000K Lumens	6,817	8,704	11,924	15,102
	BUG Rating	B1-U4-G4	B2-U5-G5	B2-U5-G5	B2-U5-G5

Lumark

AXCS / AXCL Axcent

Energy and Performance Data

Power and Lumens (Small + CBP)

Light Engin	e	AXCS1A	AXCS2A	AXCS3A	AXCS4A
Power (Watt	s)	18	25	31	48
Input Curren	t @ 120V (A)	0.15	0.21	0.26	0.40
Input Curren	t @ 240V (A)	0.08	0.11	0.13	0.20
Input Curren	t @ 277V (A)	0.07	0.09	0.11	0.18
Configurati	on				
Full	4000K/5000K Lumens	629	587	647	570
Cutoff	3000K Lumens	531	496	547	482
Refractive	4000K/5000K Lumens	667	623	686	605
Lens	3000K Lumens	563	526	580	511

Note: Power and current based on full power consumption while CBP is charging. Lumen outputs are

Power and Lumens (Large + CBP)

Light Engine		AXCL6A	AXCL8A	AXCL10
Power (Watts)	60	76	106
Input Current	@ 120V (A)	0.50	0.63	0.88
Input Current	@ 240V (A)	0.25	0.32	0.44
Input Current	@ 277V (A)	0.22	0.27	0.38
Configuratio	n			
Full	4000K/5000K Lumens		1,070	
Cutoff	3000K Lumens		945	
Refractive	4000K/5000K Lumens		1,098	
Lens	3000K Lumens		973	
Input Current Input Current Configuratio Full Cutoff Refractive	@ 240V (A) @ 277V (A) n 4000K/5000K Lumens 3000K Lumens 4000K/5000K Lumens		0.27 1,070 945 1,098	

lote: Power and current based on full power consumption while CBP is charging. Lumen outputs are while operating in emergency mode only.

Power and Lumens Multipliers (Lumen Select Back Box + Axcent Small)

	Configuration	~75% Nominal Output	~50% Nominal Output
Catalog Number	Material Number		Installation ctions
AXCS1A*	13109741 or 13109939 or Other	74%	50%
AXCS2A*	13109698 or 13109938 or Other	74%	50%
AXCS3A*	13109697 or 13109937 or Other	74%	50%
AXCS4A*	13109695 or 13109936	75%	40%
AXCS4A*	13495299 or 13495470 or Other	72%	50%
AXCS5A*	13109652 or 13109935	75%	40%
AXCS5A*	13495471 or 13495472 or Other	72%	50%

Power and Lumens Multipliers (Lumen Select Back Box + Axcent Large)

	Configuration	~75% Nominal Output	~50% Nominal Output
Catalog Number Material Number			Installation ctions
AXCL6A*	12963843 or 12964235	75%	40%
AXCL6A*	13495473 or 13495474 or Other	69%	47%
AXCL8A*	12963842 or 12964234	84%	48%
AXCL8A*	13495475 or 13495476 or Other	69%	47%
AXCL10A*	12963840 or 12964233	84%	48%
AXCL10A*	13495477 or 13495478 or Other	69%	47%
AXCL12A*	12902056 or 12902057	85%	50%
AXCL12A*	13495479 or 13495480 or Other	72%	49%

Lumen Maintenance (Axcent Small)

Ambient Temperature	TM-21 Lumen Maintenance (72,000 Hours)	Theoretical L70 (72,000 Hours)
Up to 3A		
25°C	90%	246,000
40°C	90%	225,000
50°C	89%	195,000
Up to 5A		
25°C	89%	240,000
40°C	88%	223,000
50°C	87%	186,000

Theoretical		Ambient	TM-2	21 Lumen Maint
L70	Τe	emperature		(72,000 Hours

Lumen Maintenance (Axcent Large)

Ambient Temperature	TM-21 Lumen Maintenance (72,000 Hours)	Theoretical L70 (72,000 Hours)
Up to 8A		
25°C	94%	556,000
40°C	94%	556,000
50°C	92%	340,000
Up to 10A		
25°C	94%	556,000
40°C	94%	478,000
50°C	87%	207,000
Up to 12A		
25°C	94%	151,000
40°C	81%	125,000

Lumen Multiplier

Ambient Temperature	Lumen Multiplier
10°C	1.02
15°C	1.01
25°C	1.00
40°C	0.97


0-10V This fixture is offered standard with 0-10V dimming driver(s) for use with a lighting control panel or other control method.


Photocontrol (PC1, PC2 and PC) Optional button-type photocontrol provides a flexible solution to enable "dusk-to-dawn" lighting by sensing light levels. After Hours Dim (AHD) This feature allows photocontrol-enabled luminaires to achieve additional energy savings by dimming during scheduled portions of the night. The dimming profile will automatically take effect after a "dusk-to-dawn" period has been calculated from the photocontrol input. Specify the desired dimming profile for a simple,

factory-shipped dimming solution requiring no external control wiring. Reference the After Hours Dim supplemental guide for additional information. Dimming Occupancy Sensor (MSP/DIM-LXX and MSP-LXX) These sensors are factory installed in the luminaire housing. When the MSP/DIM-LXX sensor option is selected, the occupancy sensor is connected to a dimming driver and the entire luminaire dims when there is no activity detected. When activity is detected, the luminaire returns to full light output. The MSP/DIM sensor is factory preset to dim down to approximately 50 percent power with a time delay of ten minutes. The MSP-LXX sensor is factory preset to

These occupancy sensors includes an integrated photocell that can be activated with the ISHH-01 accessory for "dusk-to-dawn" control or daylight harvesting - the factory preset is ON. The ISHH-01 is a wireless tool utilized for changing the dimming level, time delay, sensitivity and other parameters. A variety of sensor lens are available to optimize the coverage pattern for mounting heights from 8'-30'.


For mounting heights from 12' to 30' (-L30)

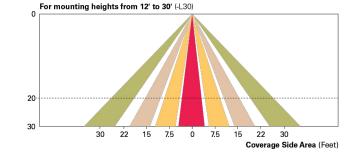

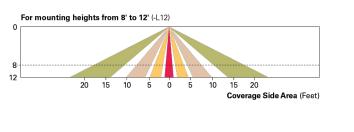



WaveLinx Wireless Control and Monitoring System The WaveLinx Outdoor control platform operates on a wireless mesh network based on IEEE 802.15.4 standards enabling wireless control of outdoor lighting. Use the WaveLinx Mobile application for set-up and configuration. At least one Wireless Area Controller (WAC) is required for full functionality and remote communication (including adjustment of any factory pre-sets).

WaveLinx Wireless Sensor (SWPD4 and SWPD5) These outdoor sensors offer passive infrared (PIR) occupancy and a photocell for closed loop daylight sensing. These sensors can be factory installed or field-installed via simple, tool-less integration into luminaires equipped with the Zhaga Book 18 compliant 4-PIN receptacle (ZW). These sensors are factory preset to dim down to approximately 50 percent power after 15 minutes of no activity detected. These occupancy sensors include an integral photocell for "dusk-todawn" control or daylight harvesting that is factory-enabled. A variety of sensor lenses are available to optimize the coverage pattern for mounting heights from 7'-40'.

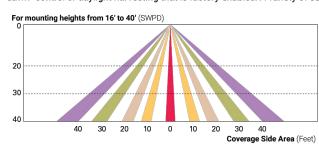

Enlighted Wireless Control and Monitoring System (LWR-LW and LWR-LN) The Enlighted System is a connected lighting solution that combines LED luminaires with an integrated wireless sensor system. The sensor controls the lighting system in compliance with the latest energy codes and collects valuable data about building performance and use. Software applications turn the granular data into information through energy dashboards and specialized apps that make it simple and help optimize the use of other

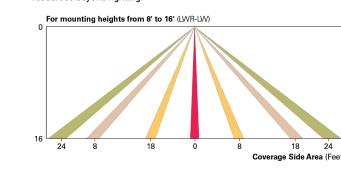

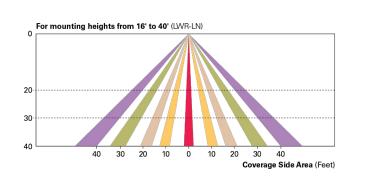

PERMISSION OF THE DESIGNER. THE DRAWINGS AND SHALL REMAIN THE PROPERTY OF THE DESIGNER EXECUTED OR NOT. THESE DRAWINGS AND ANY OTHER PROJECTS FOR ADDITIONS TO THIS PROJECT BY OTHERS EXCEPT BY THE EXPRESSED WRITTEN PERMISSION OF THE DESIGNER.

Engineer



(۵ (1) O HIGH Z 196 FR

DATE:	ISSUED FOR:
/09/2022	PERMIT

	40/00/0000
DATE:	12/09/2022
JOB NO:	22-355
DRAWN BY:	BCE
CHECKED BY:	BCE
SCALE:	AS SHOWN

SHEET NUMBER:

$+^{0.0}$ $+^{0.0}$ $+^{0.0}$ $+^{0.0}$ $+^{0.0}$ $+^{0.0}$ $+^{0.0}$ $+^{0.0}$	+0.0 $+0.0$	$\begin{array}{c ccccccccccccccccccccccccccccccccccc$	0.0 +0.0 +0.0 +0.0 +0.0 +0.0 +0.0		
$+^{0.0}$ $+^{0.0}$ $+^{0.0}$ $+^{0.0}$	+0.5 $+0.5$ $+0.5$ $+0.8$ $+3.6$ $+0.8$	+0.2 + 0.1 + 0.0 + 0.0 + 0.0 + 0.0 + 0.0 + 0.0 $+0.5 + 0.2 + 0.1 + 0.0 + 0.0 + 0.0 + 0.0 + 0.0$ $+1.5 + 0.3 + 0.2 + 0.1 + 0.1 + 0.0 + 0.0 + 0.0$ $+1.2 + 0.8 + 0.5 + 0.3 + 0.2 + 0.2 + 0.0 + 0.0$ $+4.5 + 1.2 + 0.7 + 0.7 + 0.4 + 0.3 + 0.2$ $+0.4 + 0.5 + 0.6 + 0.4$	+0.0 +0.0 +0.0 +0.0 +0.0 +0.0 +0.0 +0.0	.0 .0 .0	
$\begin{array}{cccccccccccccccccccccccccccccccccccc$	+60 +60 +60 +60 +60 +60 +60 +5.4 +3.8 +6.6 +3.0 +1.7 +3.2 +3.1 +4.5 +4.9 81	+4.0 +6.6 $+3.8 +2.6$ $+5.9 +3.1 +5.8$ $+6.0 +2.6$ $+1.6 +3.5 +5.9$ $+3.7 +4.6 +3.8 +6.2$ $+4.6 +3.8 +2.1$ $+4.7 +4.8 +2.1$ $+2.1 +4.7 +4.1$	+4.9 +6.0 +1.1 +0.2 +0.1 +0.4 +0.1 +0.0 +0.0 +0.0 +0.0 +0.0 +0.0 +0.0 +0.0 +0.0 +0.0 +0.0 +0.0 +0.0 +0.0 +0.0 +0.0		
$\begin{array}{cccccccccccccccccccccccccccccccccccc$	+7.0 +3.1 2.9	+6.7 +3.6 +17 +2.8 +5.6 +5.1 +3.3 +40 +0.0	/ / /		
+0.0 +0.0 +0.0 +0.0 +0.1 +0.2 +0.4 +0.8	$ \begin{array}{cccccccccccccccccccccccccccccccccccc$	+4.6 +5.5 +0.0 +0.0 +0.0 +0.0 +0.0 +0.0 +0.0			
+0.0 +0.0 +0.0 +0.0 +0.0 +0.0 +0.0 +0.0 +0.0 +0.0 +0.0 +0.0	$\begin{array}{cccccccccccccccccccccccccccccccccccc$	10.0 +0.0 +0.0 10.0 +0.0 +0.0 10.0 +0.0 +0.0 10.0 +0.0 +0.0 10.0 +0.0 +0.0 10.0 +0.	2697-271-02-006 Zone RILINGLESMITH ENTERPRESS LLC 1986 HIGHWAY 6 /AND 50 Acreage: \$242 PO BOX 1177 MACK OF 81525		
	$\begin{array}{cccccccccccccccccccccccccccccccccccc$	+0.0			

LIGHTING - IES-FOOTCANDLE SITE PLAN

SCALE: 1"=30'-0"

Number Lumens Lamps Per Lamp 2A AXCENT SMALL LED WALLPACK WITH 3000K CCT AND 80 CRI LEDS COOPER LIGHTING SOLUTIONS – LUMARK (FORMERLY EATON)

AXCS2A-W – MSP/DIM-L12 ISHH-01 SW1

Statistics						
Description	Symbol	Avg	Max	Min	Max/Min	Avg/Min
SITE CALC ZONE	+	1.1 fc	8.9 fc	0.0 fc	N/A	N/A

PHOTOMETRIC CALCULATION DISCLAIMER:

LIGHTING PATTERN USED FOR LUMINAIRES REPRESENTS ILLUMINATION LEVELS CALCULATED FROM LABORATORY DATA TAKEN UNDER CONTROLLED CONDITIONS IN ACCORDANCE WITH ILLUMINATING ENGINEERING SOCIETY APPROVED METHODS. ACTUAL PERFORMANCE OF ANY LUMINAIRE MAY VARY DUE TO VARIATION IN VOLTAGE, TOLERANCE IN LAMPS AND OTHER VARIABLE FIELD AND EQUIPMENT CONDITIONS.

EXTERIOR LIGHTING DESIGN CONCEPTS:

- 1. CALCULATIONS ARE USING POINT-TO-POINT METHOD WITH TEN FEET DISTANCE BETWEEN CALCULATION GRID POINTS, USING VISUAL LIGHTING CALCULATIONS SOFTWARE.
- 2. THE IESNA STANDARDS REPRESENT THE LOWEST ACCEPTABLE LEVELS FOR PROPER VISIBILITY AND RECOMMEND MINIMUM MAINTAINED LIGHT LEVELS FOR OPEN PARKING LOTS AT 0.2-0.5 FOOT CANDLE LEVELS FOR ENHANCED SECURITY CONDITIONS.
- 3. PROPOSED LIGHT FIXTURES AND LIGHT LEVELS ARE TO BE IN ACCORDANCE WITH ALL LOCAL REQUIREMENTS.

EXTERIOR LIGHTING NOTES:

- 1. LIGHT FIXTURES SHALL BE INSTALLED AND MAINTAINED IN A MANNER CONSISTENT WITH THE LIGHTING PLAN APPROVED BY THE CITY PLANNING DEPARTMENT. THE PROPERTY OWNER SHALL BE RESPONSIBLE FOR THE PROPER MAINTENANCE OF THE LIGHTING FIXTURES ON THEIR PROPERTY.
- 2. REFER TO LANDSCAPE PLANS FOR MATURE HEIGHT OF EXISTING AND PROPOSED TREES.
- 3. REFER TO ARCHITECTURAL ELEVATIONS FOR BUILDING HEIGHT INFORMATION.

 4. ALL EXTERIOR LIGHT ENTERED SHALL BE OPERATED BY ASTRONOMICAL TIME CLOCK, PHOTOCELL OR
- LIGHTING CONTROL SYSTEM.

 5. POST-CURFEW LIGHT LEVELS FOR PARKING LOTS SHALL BE REDUCED BY AT LEAST 50%. ENTRY LIGHTS
- POST-CORFEW LIGHT LEVELS FOR PARKING LOTS SHALL BE REDUCED BY AT LEAST 50%. ENTRY LIGHTS MAY BE LEFT ON.
 FACILITIES & SITE DEVELOPMENT OF THIS SITE ARE TO BE CONSTRUCTED IN ACCORDANCE WITH CITY CONSTRUCTION SPECIFICATIONS, STANDARDS AND DETAILS.
 ALL OUTSIDE LIGHT SOURCES SHALL CONFORM TO ALL LOCAL ZONING & DEVELOPMENT CODES.
 PARKING LOT LIGHTS SHALL OPERATE DUSK TO PRE-SET OFF, SO THAT THEY EXTINGUISH ONE HOUR AFTER CLOSE OF BUSINESS OR NO LATER THAN 10 P.M. BUILDING SECURITY LIGHTS WILL OPERATE FROM DUSK TO DAWN.

ACCEPTANCE BLOCK

THE CITY REVIEW CONSTITUTES GENERAL COMPLIANCE WITH THE CITY'S DEVELOPMENT STANDARDS, SUBJECT TO THESE PLANS BEING SEALED, SIGNED, AND DATED BY THE PROFESSIONAL OF RECORD. REVIEW BY THE CITY DOES NOT CONSTITUTE APPROVAL OF THE PLAN DESIGN. THE CITY NEITHER ACCEPTS NOR ASSUMES ANY LIABILITY FOR ERRORS OR OMISSIONS. ERRORS IN THE DESIGN OR CALCULATIONS REMAIN THE RESPONSIBILITY OF THE PROFESSIONAL OF RECORD.

CONSTRUCTION MUST COMMENCE WITHIN ONE YEAR FROM THE DATE OF PLAN SIGNATURE.

CITY DEVELOPMENT ENGINEER	DATE

CITY PLANNER

SPECIFICATIONS WITHOUT THE EXPRESSED WRITTEN
PERMISSION OF THE DESIGNER. THE DRAWINGS AND SPECIFICATIONS ARE INSTRUMENTS OF THE SERVICE AND SHALL REMAIN THE PROPERTY OF THE DESIGNER WHETHER THE PROJECT FOR WHICH THEY ARE MADE IS EXECUTED OR NOT. THESE DRAWINGS AND SPECIFICATIONS SHALL NOT BE USED BY ANYONE ON ANY OTHER PROJECTS FOR ADDITIONS TO THIS PROJECT BY OTHERS EXCEPT BY THE EXPRESSED WRITTEN PERMISSION OF THE DESIGNER.





PLACE SITE STORALE SI,
1960 HIGHWAY 6 & 50
FRUITA, COLORADO

DATE: ISSUED FOR: 12/09/2022 PERMIT

	$\overline{}$
DATE:	12/09/2022
JOB NO:	22-355
DRAWN BY:	BCE
CHECKED BY:	BCE
SCALE:	AS SHOW
SHEET NUMBER:	

IES1

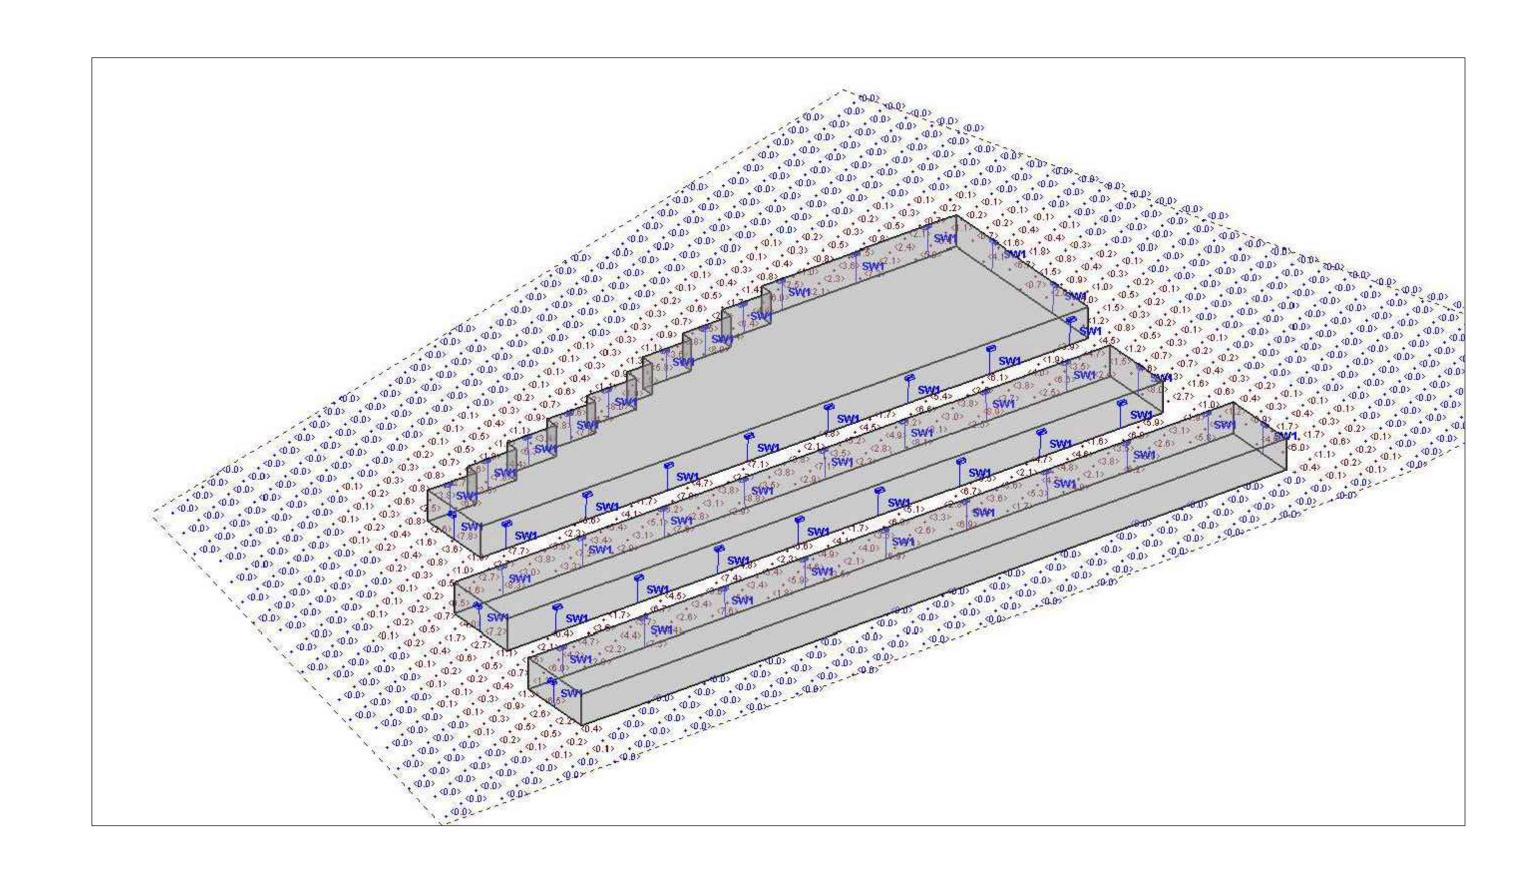

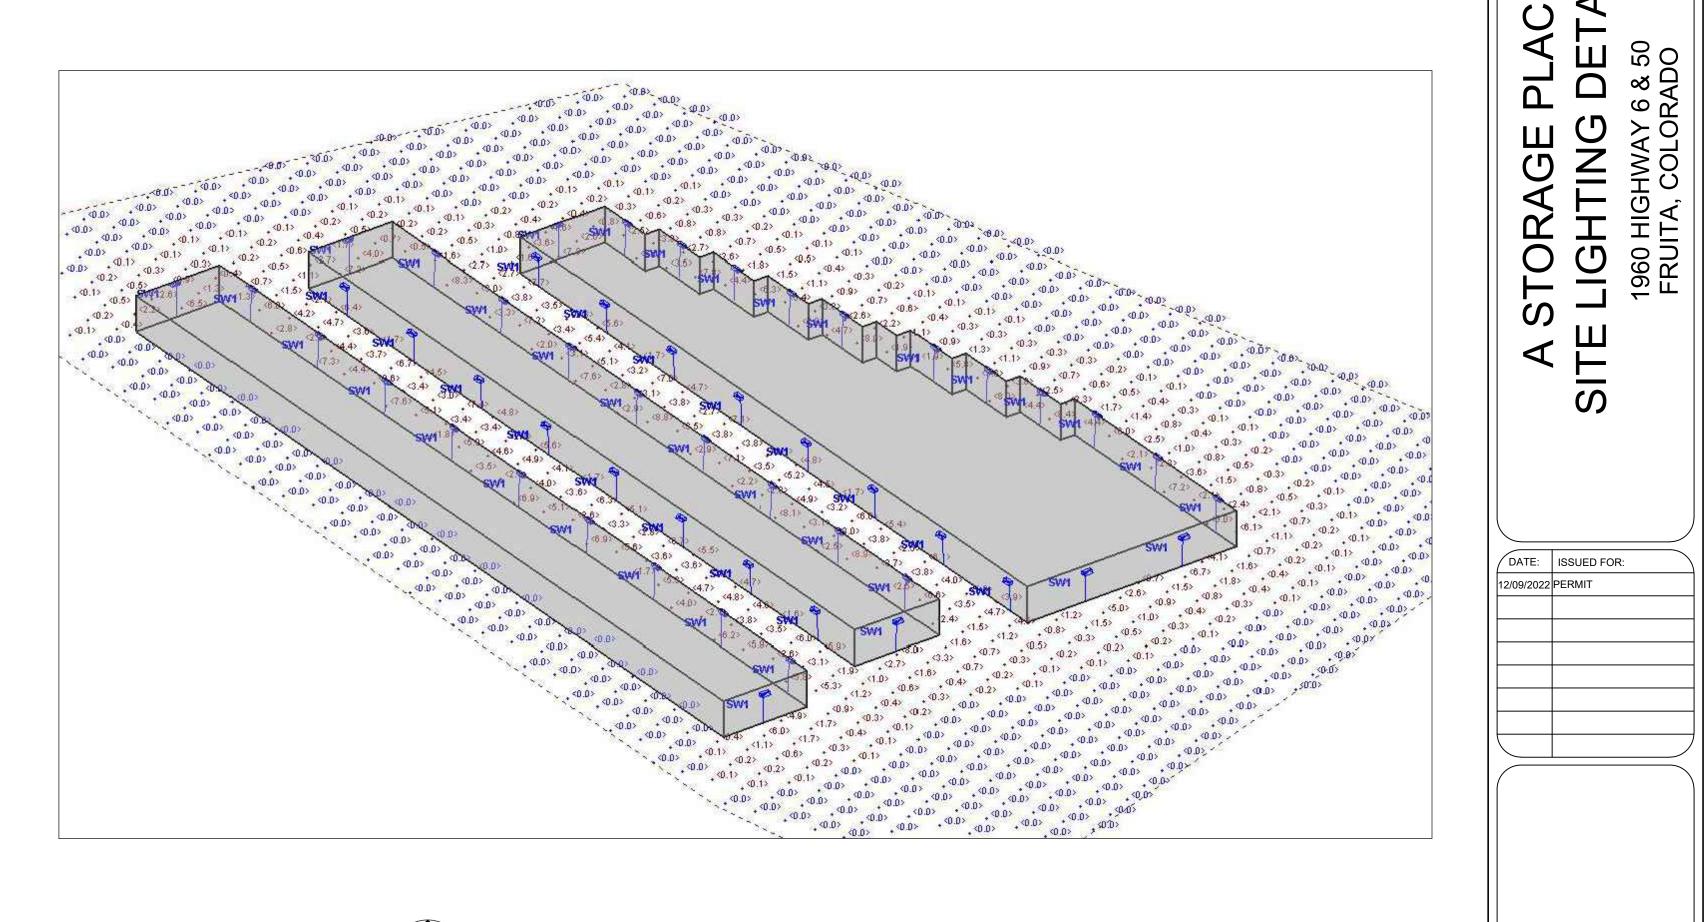



SPECIFICATIONS WITHOUT THE EXPRESSED WRITTEN
PERMISSION OF THE DESIGNER. THE DRAWINGS AND SPECIFICATIONS ARE INSTRUMENTS OF THE SERVICE AND SHALL REMAIN THE PROPERTY OF THE DESIGNER SHALL REMAIN THE PROPERTY OF THE DESIGNER WHETHER THE PROJECT FOR WHICH THEY ARE MADE IS EXECUTED OR NOT. THESE DRAWINGS AND SPECIFICATIONS SHALL NOT BE USED BY ANYONE ON ANY OTHER PROJECTS FOR ADDITIONS TO THIS PROJECT BY OTHERS EXCEPT BY THE EXPRESSED WRITTEN PERMISSION OF THE DESIGNER.



LIGHTING DET 1960 HIGHWAY 6 & 50 FRUITA, COLORADO PLA ORA ST SITE \triangleleft

12/09/2022 22-355 BCE DRAWN BY: BCE CHECKED BY: SCALE: AS SHOWN SHEET NUMBER:

IES1-2